


MISS UTILITY

CALL "MISS UTILITY" AT 1-800-257-7777, 48 HOURS PRIOR TO THE START OF WORK. THE EXCAVATOR MUST NOTIFY ALL PUBLIC UTILITY COMPANIES WITH UNDER GROUND FACILITIES IN THE AREA OF PROPOSED EXCAVATION AND HAVE THOSE FACILITIES LOCATED BY THE UTILITY COMPANIES PRIOR TO COMMENCING EXCAVATION. THE EXCAVATOR IS RESPONSIBLE FOR COMPLIANCE WITH REQUIREMENTS OF MARYLAND CODES AND REGULATIONS.

ARIS ALLEN BOULEVARD (SR - 665)

ARIS ALLEN BOULEVARD (SR - 665)

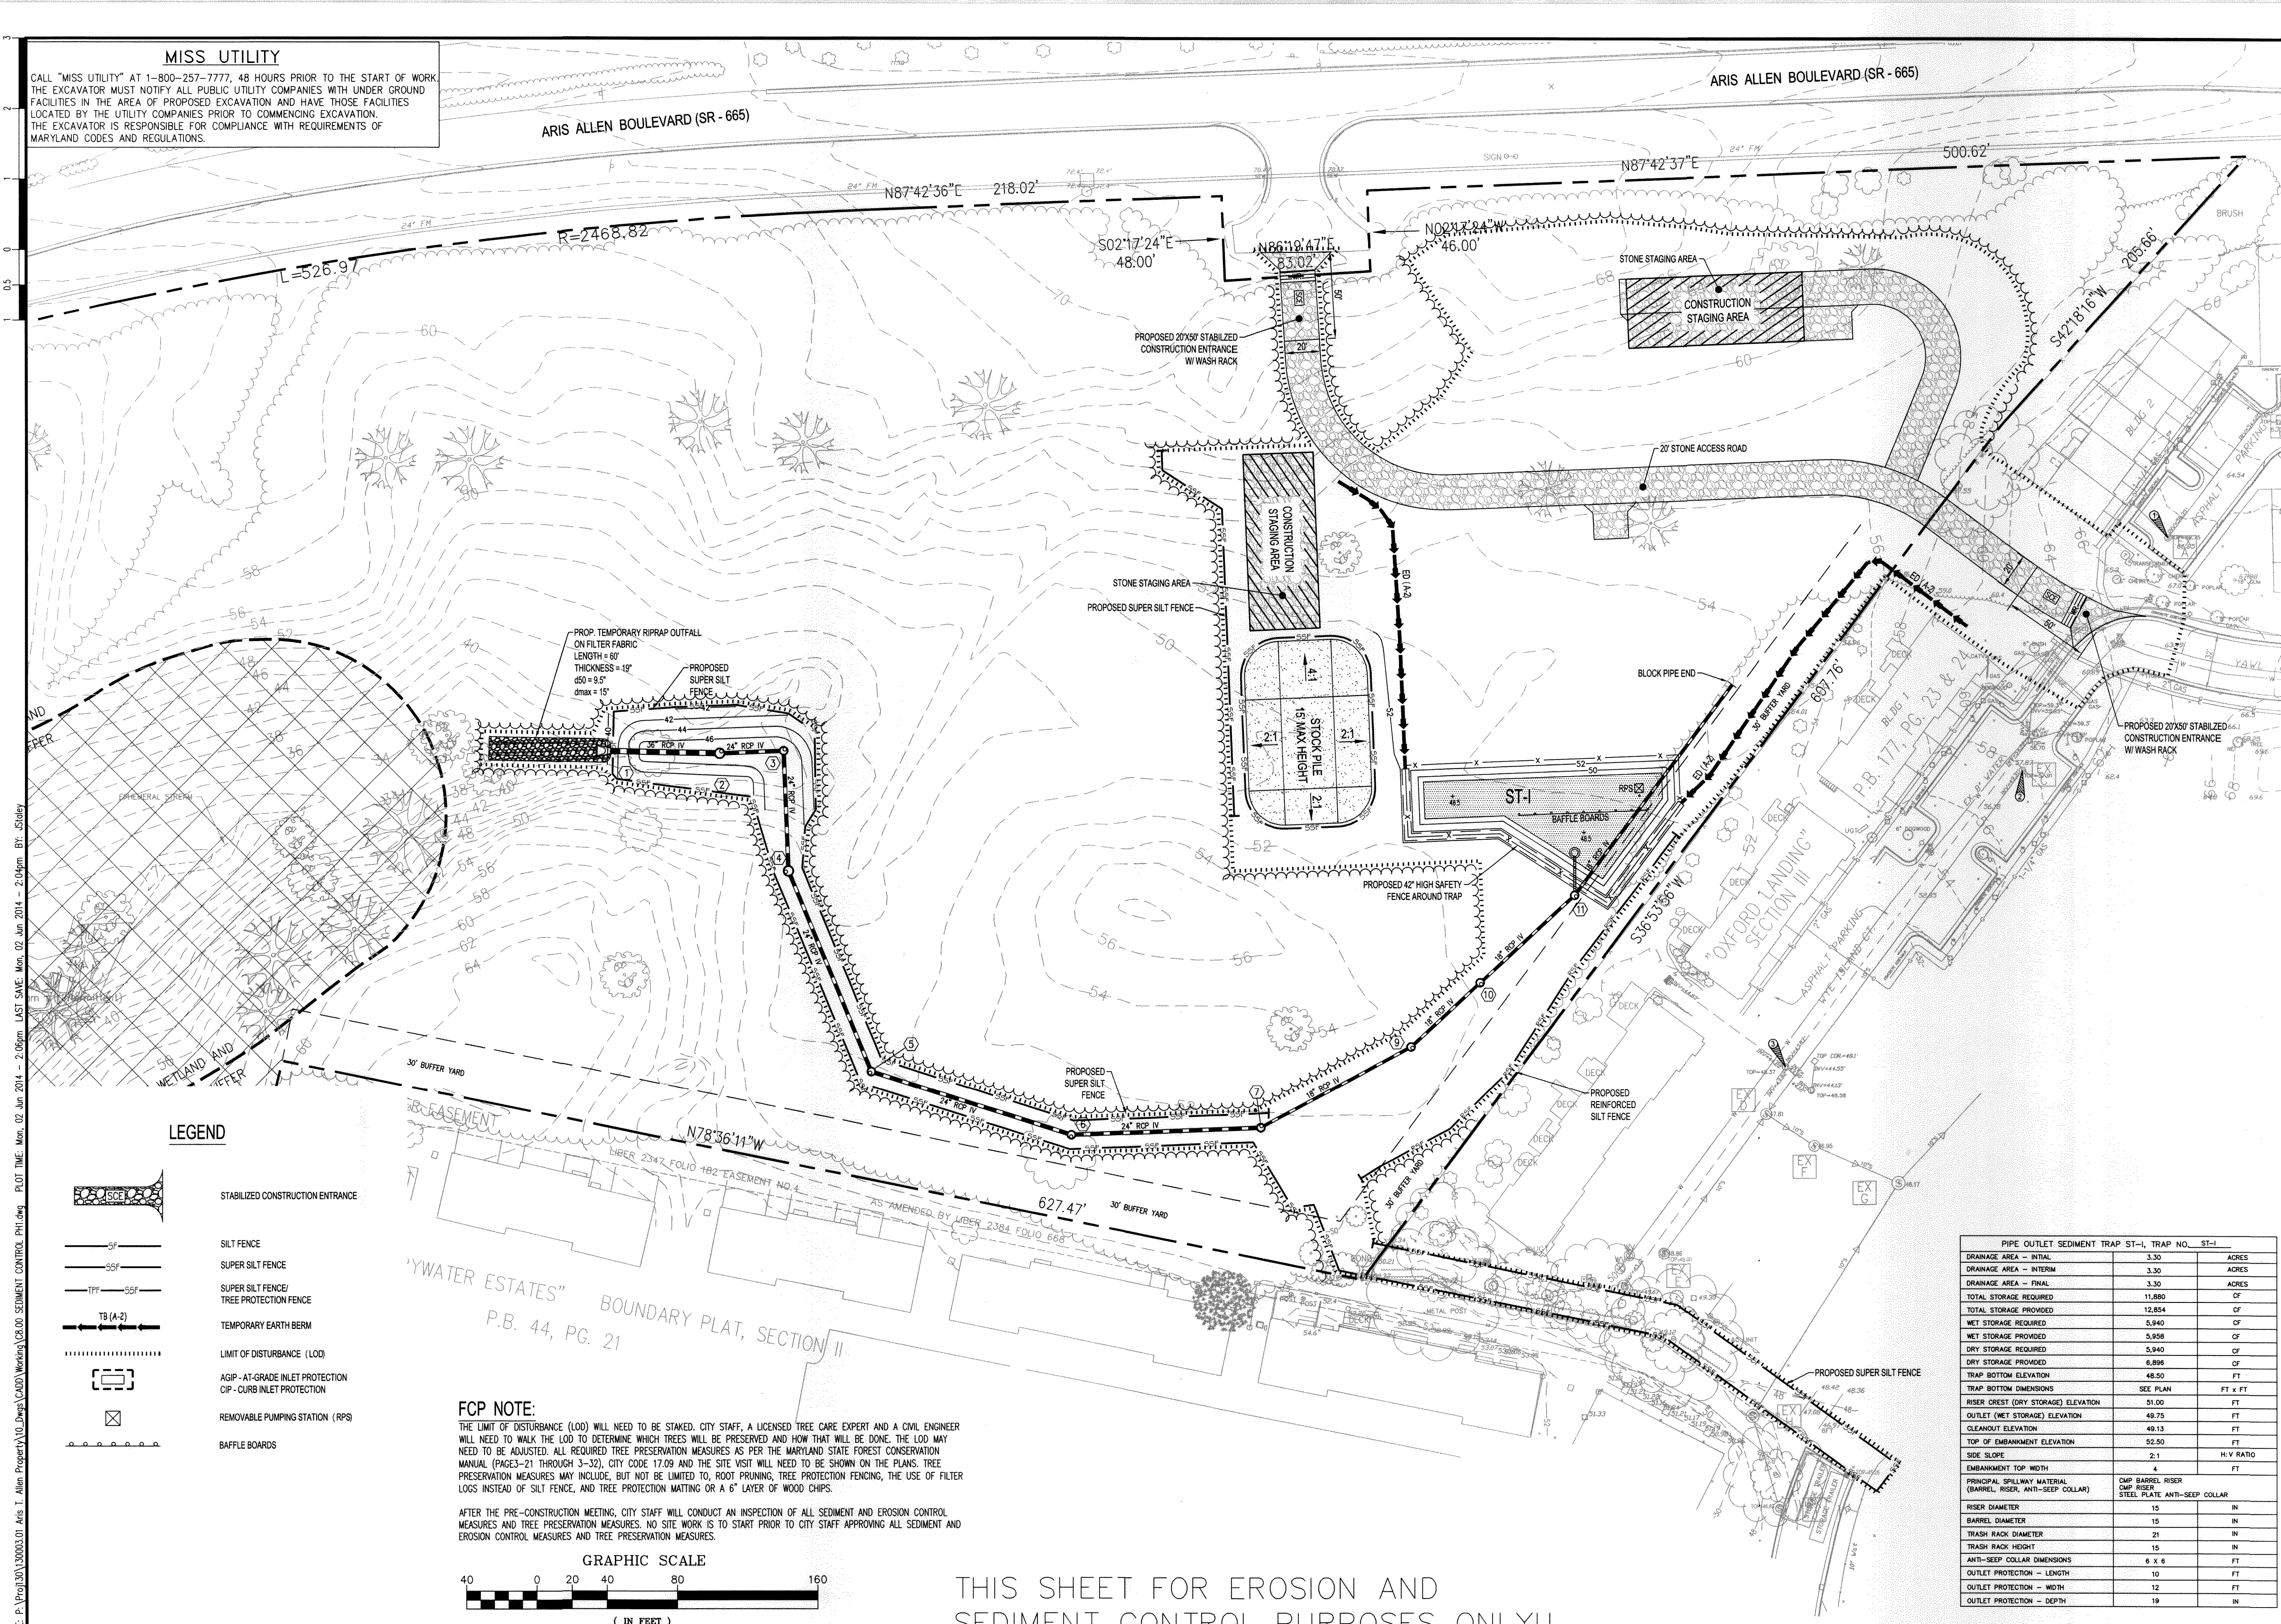

LEGEND


- STABILIZED CONSTRUCTION ENTRANCE
- SILT FENCE
- SUPER SILT FENCE
- SUPER SILT FENCE/ TREE PROTECTION FENCE
- TEMPORARY EARTH BERM
- LIMIT OF DISTURBANCE (LOD)
- AGIP - AT-GRADE INLET PROTECTION
CIP - CURB INLET PROTECTION
- REMOVABLE PUMPING STATION (RPS)
- BAFFLE BOARDS

FCP NOTE:

THE LIMIT OF DISTURBANCE (LOD) WILL NEED TO BE STAKED. CITY STAFF, A LICENSED TREE CARE EXPERT AND A CIVIL ENGINEER WILL NEED TO WALK THE LOD TO DETERMINE WHICH TREES WILL BE PRESERVED AND HOW THAT WILL BE DONE. THE LOD MAY NEED TO BE ADJUSTED. ALL REQUIRED TREE PRESERVATION MEASURES AS PER THE MARYLAND STATE FOREST CONSERVATION MANUAL (PAGES 21 THROUGH 3-32), CITY CODE 17.09 AND THE SITE VISIT WILL NEED TO BE SHOWN ON THE PLANS. TREE PRESERVATION MEASURES MAY INCLUDE, BUT NOT BE LIMITED TO, ROOT PRUNING, TREE PROTECTION FENCING, THE USE OF FILTER LOGS INSTEAD OF SILT FENCE, AND TREE PROTECTION MATING OR A 6\"/>

AFTER THE PRE-CONSTRUCTION MEETING, CITY STAFF WILL CONDUCT AN INSPECTION OF ALL SEDIMENT AND EROSION CONTROL MEASURES AND TREE PRESERVATION MEASURES. NO SITE WORK IS TO START PRIOR TO CITY STAFF APPROVING ALL SEDIMENT AND EROSION CONTROL MEASURES AND TREE PRESERVATION MEASURES.

GRAPHIC SCALE

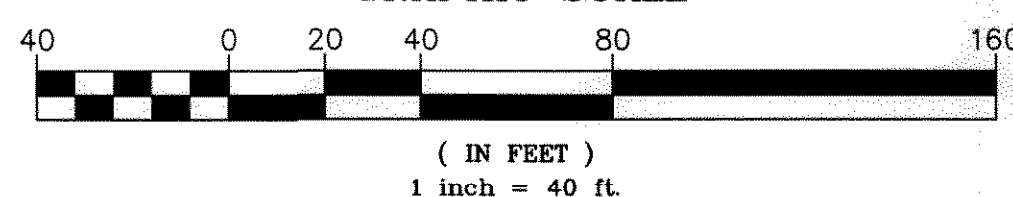


THIS SHEET FOR EROSION AND SEDIMENT CONTROL PURPOSES ONLY!!

PIPE OUTLET SEDIMENT TRAP ST-I, TRAP NO. ST-I		
DRAINAGE AREA - INITIAL	3.30	ACRES
DRAINAGE AREA - INTERIM	3.30	ACRES
DRAINAGE AREA - FINAL	3.30	ACRES
TOTAL STORAGE REQUIRED	11,880	CF
TOTAL STORAGE PROVIDED	12,854	CF
WET STORAGE REQUIRED	5,940	CF
WET STORAGE PROVIDED	5,958	CF
DRY STORAGE REQUIRED	5,940	CF
DRY STORAGE PROVIDED	6,896	CF
TRAP BOTTOM ELEVATION	48.50	FT
TRAP BOTTOM DIMENSIONS	SEE PLAN	FT x FT
RISER CREST (DRY STORAGE) ELEVATION	51.00	FT
OUTLET (WET STORAGE) ELEVATION	49.75	FT
CLEANOUT ELEVATION	49.13	FT
TOP OF EMBANKMENT ELEVATION	52.50	FT
SIDE SLOPE	2:1	H:V RATIO
EMBANKMENT TOP WIDTH	4	FT
PRINCIPAL SPILLWAY MATERIAL (BARREL, RISER, ANTI-SEEP COLLAR)	CMP BARREL, RISER, STEEL PLATE ANTI-SEEP COLLAR	
RISER DIAMETER	15	IN
BARREL DIAMETER	15	IN
TRASH RACK DIAMETER	21	IN
TRASH RACK HEIGHT	15	IN
ANTI-SEEP COLLAR DIMENSIONS	6 X 6	FT
OUTLET PROTECTION - LENGTH	10	FT
OUTLET PROTECTION - WIDTH	12	FT
OUTLET PROTECTION - DEPTH	19	IN



PROJECT
ARIS T. ALLEN BOULEVARD
RESIDENTIAL PLANNED DEVELOPMENT
PART 1 - LOTS 26 - 31, 47 & 48
6TH ELECTION DISTRICT
CITY OF ANNAPOLIS, MARYLAND
TAX MAP/GRID 51E/8

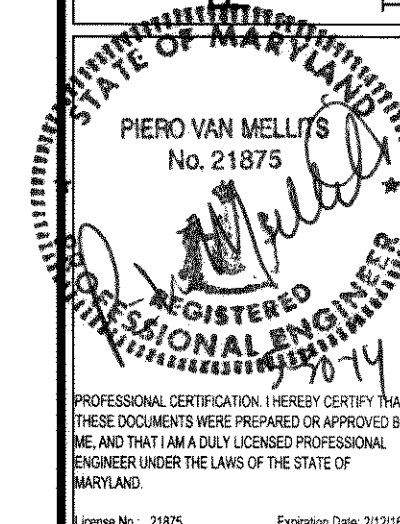

PROJECT NO. 130003.01
SCALE AS SHOWN
DATE 5/30/2014
DRAWN BY JDS/CLW
CHECKED BY PWM/TJC
DRAWING NO. AASCD #2 OF 9
C8.00

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DRAWING NO. AASCD #2 OF 9
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16 OF 66 SHEETS

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